

# NATIONAL SENIOR CERTIFICATE

**GRADE 12** 

ENGINEERING GRAPHICS AND DESIGN P1
FEBRUARY/MARCH 2010

MARKS: 100

TIME: 3 hours

This question paper consists of 6 pages.

# **INSTRUCTIONS AND INFORMATION**


- 1. This question paper consists of FOUR questions.
- 2. Answer ALL the questions.
- 3. ALL drawings are in first-angle orthographic projection, unless stated otherwise.
- 4. ALL drawings must be drawn to scale 1:1, unless stated otherwise.
- 5. ALL the questions must be answered on the QUESTION PAPER as instructed.
- 6. ALL the pages must be restapled in numerical sequence, irrespective of whether the question was attempted or not.
- 7. Time management is essential in order to complete all the questions.
- 8. Print your examination number in the block provided on every page.
- 9. Any details or dimensions not given, must be assumed in good proportion.
- 10. ALL answers must be drawn accurately and neatly.

FOR OFFICIAL USE ONLY											
QUESTION	MARKS OBTAINED		1/2	SIGN	MODERATED			1/2	SIGN		
1											
2											
3											
4											
TOTAL											
	2	0	0			2	0	0			

FINAL CONVERTED MARK	CHECKED BY
100	

COMPLETE THE FOLLOWING:
CENTRE NUMBER
CENTRE NUMBER
EXAMINATION NUMBER
EXAMINATION NUMBER

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Please turn over

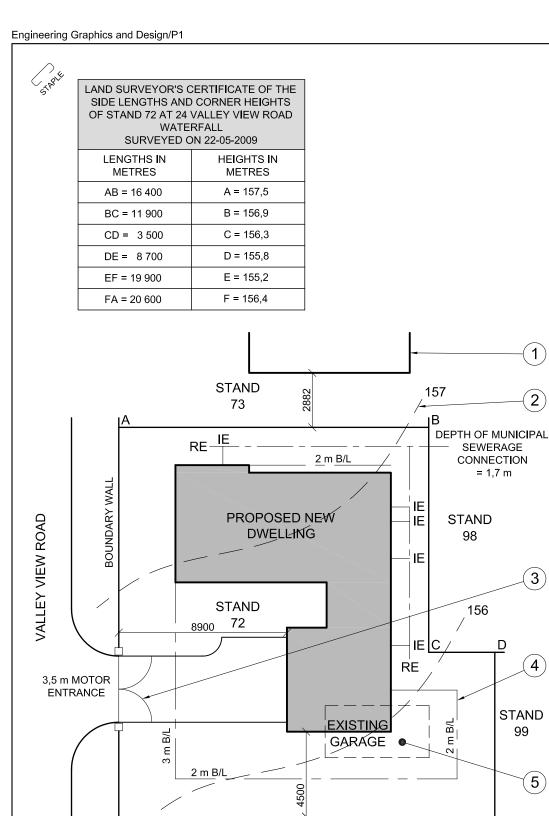

STAND 71

#### NOTE:

Contractors must verify all dimensions and levels on site before commencing work. Architects to be immediately notified of any discrepancies.

19. In the space below, draw, in neat freehand, the front view and top view of the *SABS* convention for a washbasin.

# QUESTION 1: ANALYTICAL (CIVIL)

#### Given

The site plan of a proposed new dwelling with a title block and a table of questions.

#### Instructions:

Complete the table below by neatly printing the answers to the questions which all refer to the accompanying drawings and title block. [30]

	QUESTIONS	ANSWERS
1	What is the name of the architectural firm responsible for designing the dwelling?	1
2	What scale is indicated for the drawing?	1
3	What is the reference code for the drawing?	1
4	Who checked the drawing?	1
5	How many times has the drawing been revised?	1
6	What does the line labelled 1 indicate?	1
7	What does the line labelled 2 indicate?	1
8	What does the curve labelled 3 indicate?	1
9	What does the line labelled 4 indicate?	1
10	What must happen with the existing garage labelled 5?	1
11	What is the street address of the new dwelling?	1
12	What is the stand number to the northeast of stand 72?	2
13	How far is the new dwelling from the southwestern boundary line?	2
14	What is the depth of the municipal sewerage connection?	2
15	What colour must all new concrete be on sectional elevations of presentation drawings?	2
16	What colour must all new buildings be on the site plan of presentation drawings?	1
17	Determine the total area of the stand in square metres.	3
18	If the total area of the new dwelling is 125 m², determine the percentage of the stand that is covered by the new dwelling.	3
19	In the space provided on the title block, draw, in neat freehand, the front view and top view of the <i>SABS</i> convention for a washbasin.	4
	TOTAL	30
		,
-		
1		EXAMINATION NUMBER
		EXAMINATION NUMBER

# GOVENDER & SONS ARCHITECTS

DATE

DESCRIPTION

12th AVENUE WATERFALL Tel: 031 709 8943

PRINTED BY DATE OF PRINT 09-05-2009

DRAWING TITLE

REVISION

ARCHITECT'S SIGNATURE ..

CLIENT'S SIGNATURE ..

SITE PLAN

PROJECT

NEW DWELLING FOR LP BARKER ON STAND 72 AT 24 VALLEY VIEW ROAD WATERFALL

PROJECT NUM	1BER	DRAWING NUMBER			
25-01	-2009	Q1P1-S-2010			
REFERENCE C	ODE	DRAWN BY	CHECKED BY		
Q1P1-	S-2010	MARC	CRAIG		
SCALE	DATE				
1:200	25-03-09				

**EXAMINATION NUMBER** 


# QUESTION 2: DEVELOPMENT


NSC

The front view and top view of a rectangular-to-square transition piece.

## Instructions:

- 2.1 Draw, to scale 1:1 and in first-angle orthographic projection, the following views of the transition piece:
  - 2.1.1 The top view
  - 2.1.2 The front view
  - 2.1.3 The left view
- 2.2 Develop the surface of the transition piece. Make the edge marked AB the seam.
- 2.3 Show ALL necessary construction and fold lines. [34]

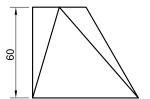

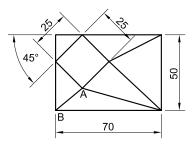


EDGE AB IS THE SEAM.

ASSESSMENT CRITERIA						
TOP + FRONT + LEFT VIEW	9					
TRUE LENGHTS	8					
DEVELOPMENT	17					
TOTAL	34					
EXAMINATION NUMBER						

**EXAMINATION NUMBER** 

Please turn over



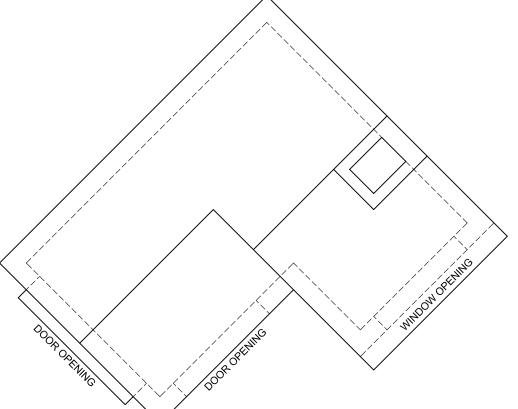

# **QUESTION 3: PERSPECTIVE**

### Given:

Two views of a simple building and the information needed to draw a two-point perspective drawing.

PP - Picture Plane

HL - Horizon Line

GL - Ground Line

SP - Station Point


### Instructions:

Complete the perspective drawing.

- Align the drawing sheet with the horizon line (HL).
- Locate and label the vanishing points.
- Show ALL visible detail inside the building.
- NO hidden detail is required.
- Show ALL necessary construction.

[39]

PP

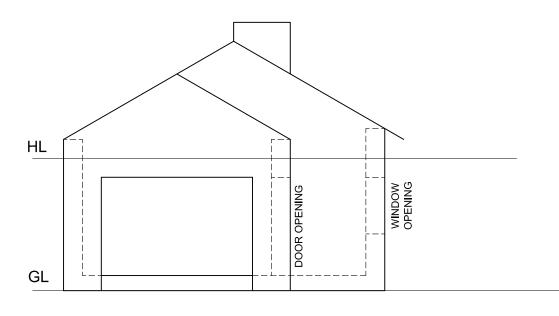

+ SP

ŀ	ΗL
ASSESSMENT CRITERIA	

 ASSESSMENT CRITERIA

 CONSTRUCTION + VPs
 5

 PART (A)
 16½

 PART (B)
 6½


 ROOF + CHIMNEY
 11


 TOTAL
 39

 EXAMINATION NUMBER

EXAMINATION NOMBER

EXAMINATION NUMBER

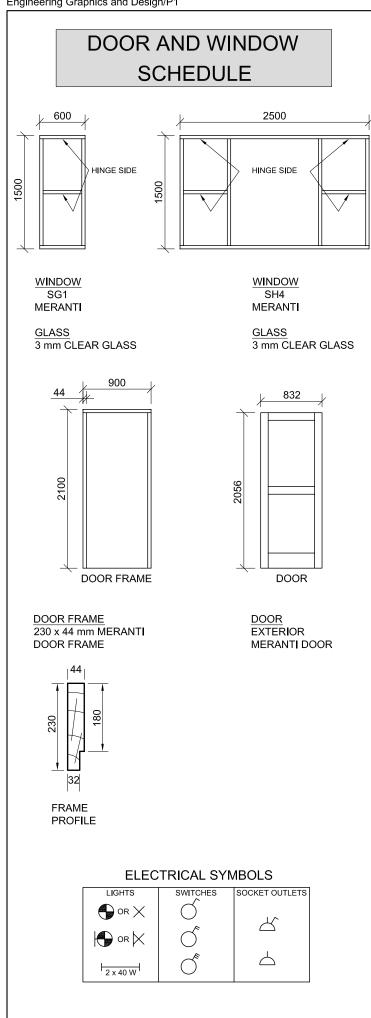

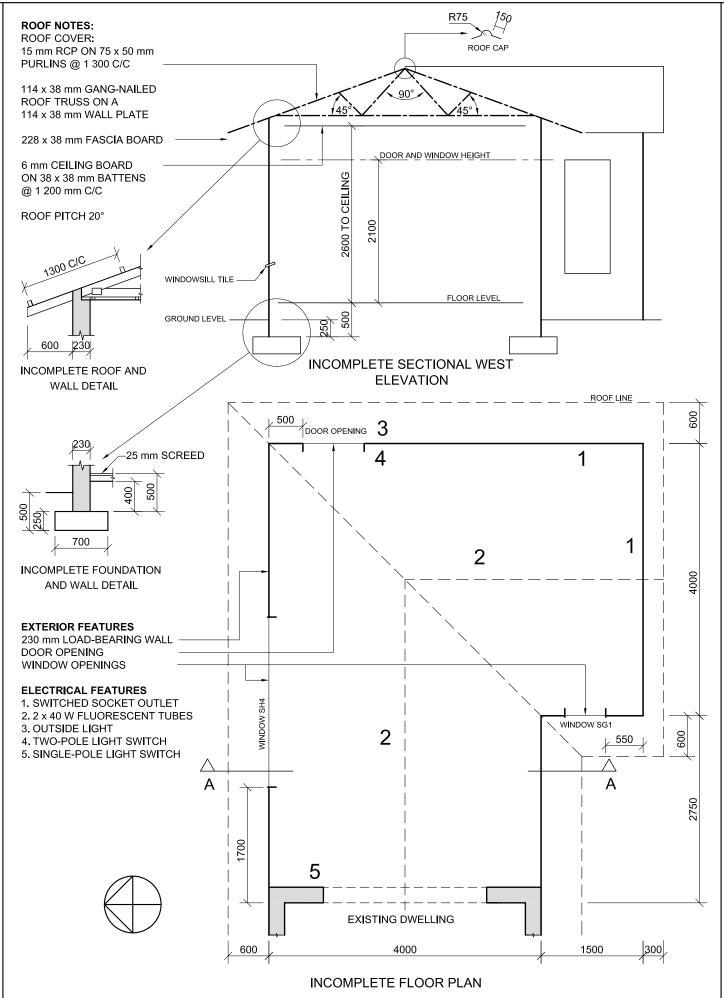

### **QUESTION 4: CIVIL DRAWING**

- The incomplete sectional west elevation on cutting plane A-A of a new family room showing the outline of the walls and a schematic drawing of the roof truss
- The incomplete floor plan of the new family room showing the outline of the walls and the positions of all the features, notes and dimensions
- A door and window schedule
- A table of electrical symbols
- The incomplete roof and wall detail
- The incomplete foundation and wall detail
- The complete north elevation of the new family room, drawn to scale, on page 6

#### Instructions:

- Answer this question on page 6.
- Using the given north elevation as a guide, draw, to scale 1:50 and according to the given specifications:

## 4.1 The complete floor plan

- 4.2 The complete sectional west elevation on cutting
- ALL drawings must comply with the guidelines contained in the SABS 0143.

### **SPECIFICATIONS:**

THE FLOOR PLAN

### Show the following features on the drawing:

- ALL the walls with hatching detail
- The door and windows
- ALL the electrical features as indicated with numbers on the incomplete floor plan
- The roof line
- The cutting plane A-A

### THE SECTIONAL WEST ELEVATION

### Show the following features on the drawing:

- The complete foundation, wall, slab and roof truss detail
- The door and window detail
- ALL hatching detail
- ALL other detail of the family room as seen from the west


# Label the following:

- The floor plan, including the scale
- The sectional elevation
- Using the correct abbreviations, label the following features on the correct view: natural ground level, damp-proof course, room designation (family room) and floor finish (ceramic tile)

#### NOTE:

ALL substructure hatching may be drawn in freehand. [97]



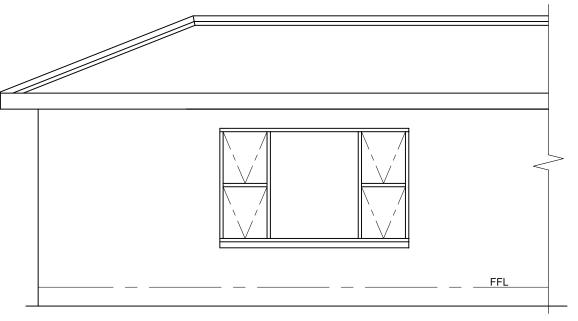

NORTH ELEVATION

ASSESSMENT CRITERIA									
SECTIONAL WEST ELEVATION									
		POSSIBLE	OBTAINED	SIGN	MODERA	ATE			
1	ROOF + CEILING	24 <sup>1</sup> / <sub>2</sub>							
2	WINDOW + DOOR	14							
4	WALLS + FLOOR + FOUNDATION	11½							
5	HATCHING	5½							
6	LABELS	3 <u>1</u>							
	SUBTOTAL	59							
		FLOOR	PLAN						
1	ROOF	4							
2	WINDOWS + DOOR	7							
3	WALLS	9							
4	ELECTRICAL	8 <u>1</u>							
5	HATCHING	3 <u>1</u>							
6	LABELS + A-A	6							
SUBTOTAL		38							
	TOTAL	97							
	EXAMINATION NUMBER								
EXAMINATION NUMBER 6									

EXISTING DWELLING